PROPOSED EXTENSION

34 ETHELWYN STREET, HILTON



CITY OF FREMANTLE These Plans Form Part of DA0343/25

9 Oct 2025



DRAWING LIST				
SHEET No.	SHEET NAME	REV	REV DATE	
A0.00	COVER PAGE	В	02/09/25	
A1.01	EXISTING FEATURE SURVEY	В	02/09/25	
A1.03	SITE PLAN	В	02/09/25	
A2.01	EXISTING FLOOR PLAN	В	02/09/25	
A2.02	EXISTING 3D PERSPECTIVES	В	02/09/25	
A4.01	PROPOSED GROUND FLOOR PLAN	В	02/09/25	
A4.02	PROPOSED SETOUT PLAN	В	02/09/25	
A4.03	PROPOSED CEILING AND ROOF PLAN	В	02/09/25	
A4.04	PROPOSED ELEVATIONS	В	02/09/25	

PRINT IN COLOUR

B 02/09/25 A 12/08/25 REV DATE

ISSUED FOR DA
PRELIMINARY DA ISSUED FOR CLIENT REVIEW
DISCRIPTION




SHEET SIZE	ов 25-181
A2	AS SHOWN
COUNCIL	DRAWN
CITY OF	MV
	DESIGNER MV

34 ETHELWYN STREET
HILTON
TITLE
COVER PAGE

DRG No A0.00 REVISION E





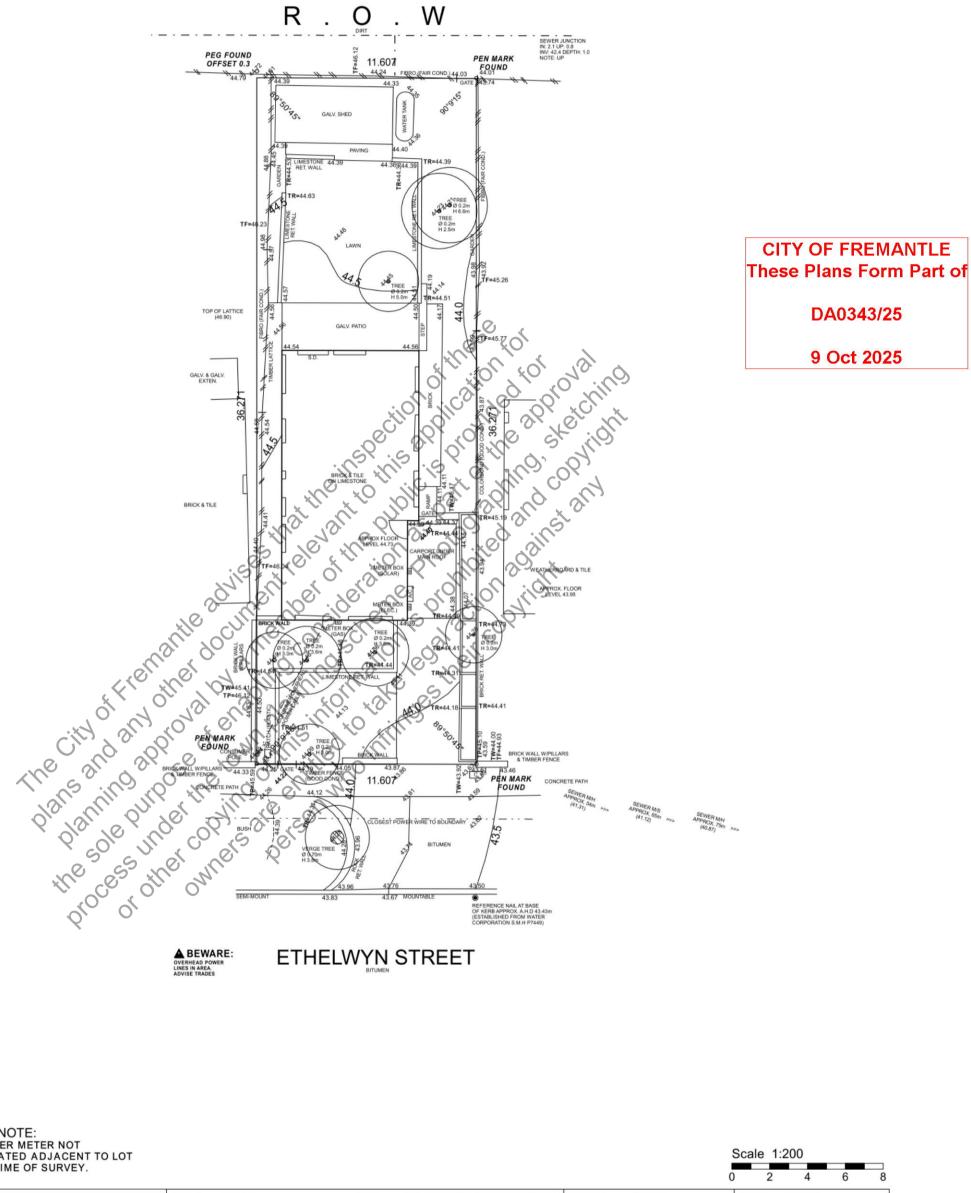

0.000 m

LOT MISCLOSE

DISCLAIMER:

Due to lack of survey marks/pegs, all building offset dimensions & features are approximate only and positioned from existing pegs/fences and walls which may not be on the correct alignment. Any design that involves additions to any structures shown or portion of structures remaining after any demolition has taken place requires boundaries. any demolition has taken place requires boundaries to be repegged and exact offsets provided to your designer/architect before any plans are produced and before any work is started on site.

and before any work is started on site.

DISCLAIMER:
Lot boundaries drawn on survey are
based on landgate plan only. Survey does not
include title search and as such may not show
easements or other interests not shown on plan.
Title should be checked to verify all lot details
and for any easements or other interests which
may affect building on the property.

▲ DISCLAIMER: Survey does not include verification of cadastral boundaries. All features and levels shown are boundaries. An leatures and veres shown based on orientation to existing pegs and fences only which may not be on correct cadastral alignment. Any designs based or dependent on the location of existing features should have those features' location verified in relation to the true boundary.

▲ DISCLAIMER:

Survey shows visible features only and will not show locations of underground pipes or conduits for internal or mains services. Verification of the location of all internal and mains services should be confirmed prior to finalisation of any design work.

DISCLAIMER:

Cottage & Engineering surveys accept no responsibility for any physical on site changes to the parcel or portion of the parcel of land shown on this survey including any adjoining neighbours levels and features that have occurred after the date on this survey. All Sewer details plotted from information supplied by Water Corporation.

WATER METER NOT LOCATED ADJACENT TO LOT AT TIME OF SURVEY.

JOB# Lat: -32.061930 Long: 115.782337 ROADS ELEC. 599750 Bitumen O/Head CLIENT Fidge, Jonty **KERBS** Mountable / Semi-Mount COMMS. Yes ADDRESS #34 Ethelwyn Street FOOTPATH Concrete WATER Yes(Not Loc) LOT Lot 71 (Plan 2556) SUBURB Hilton SOIL GAS Sand Check Alinta LGA CITY OF FREMANTLE **AREA** 443m² VOL. 22 FOL. 173A DRAINAGE Good SEWER Yes **VEGETATION** Light Grass Cover COASTAL No DRAWN K. Hesketh DATE 19 Feb 25 SSA No

PRINT IN COLOUR 02/09/25

12/08/25

DATE

ISSUED FOR DA PRELIMINARY DA ISSUED FOR CLIENT REVIEW DESCRIPTION



SHEET SIZE 25-181 SCALE AS SHOWN COUNCIL DRAWN MV CITY OF DESIGNER


MV

PROJECT 34 ETHELWYN STREET HILTON **EXISTING FEATURE SURVEY**

REVISION

A1.01


FREMANTLE © copyright of designs shown herein is retained by van der haus, written authority is required for any reproduction

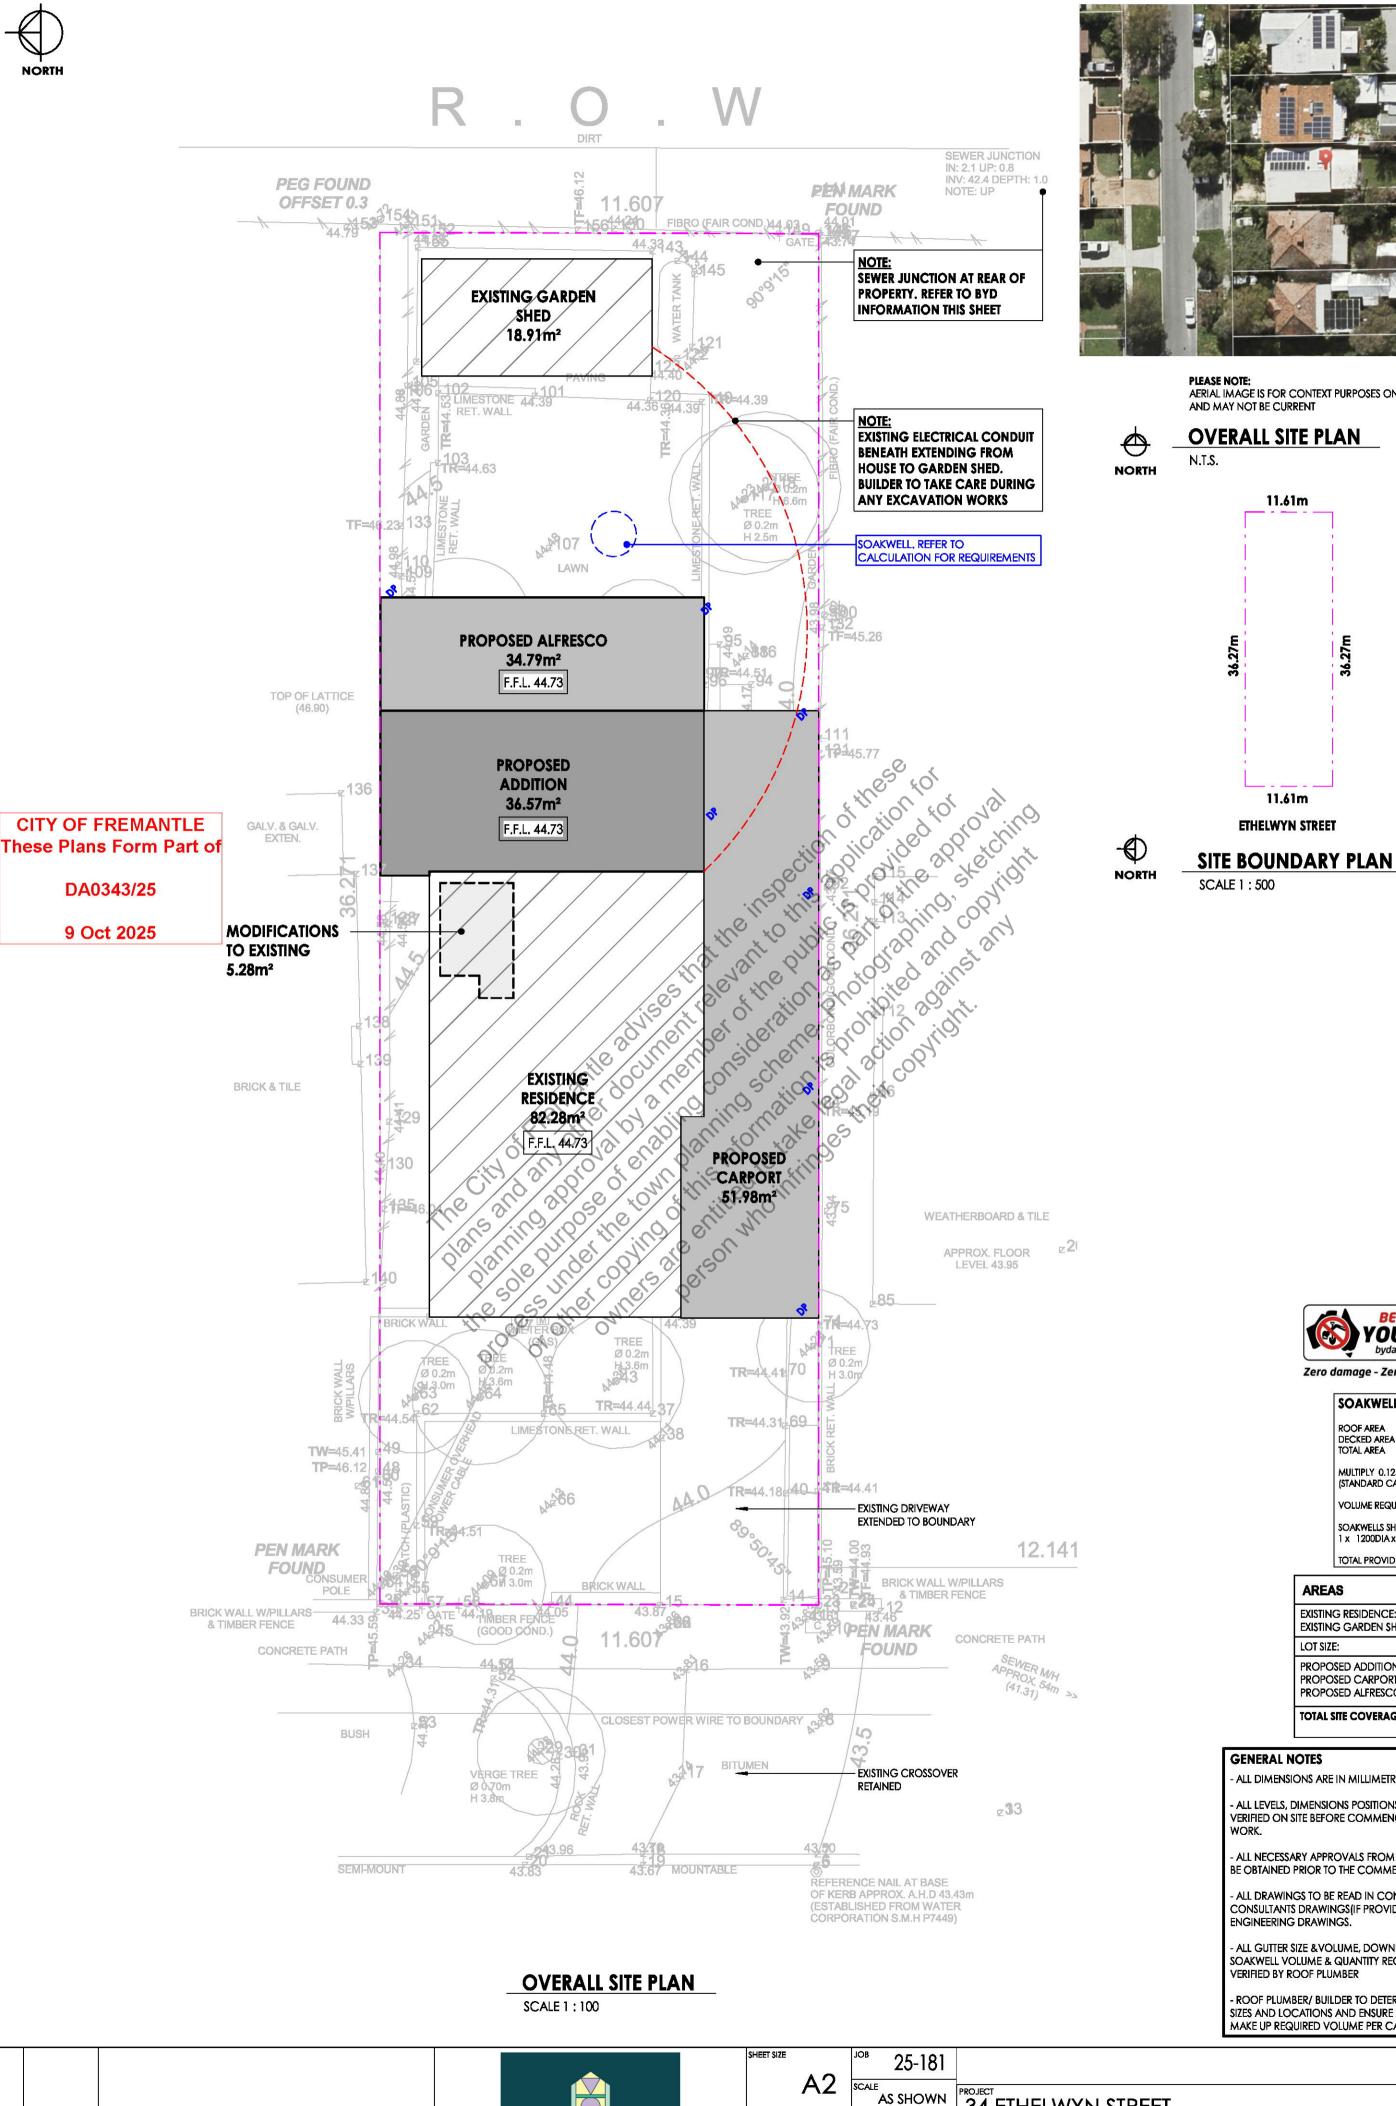



PLEASE NOTE:
AERIAL IMAGE IS FOR CONTEXT PURPOSES ONLY AND MAY NOT BE CURRENT

OVERALL SITE PLAN

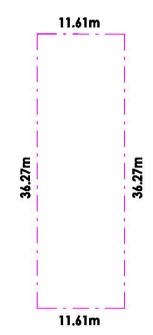

ETHELWYN STREET

SCALE 1:500



Zero damage - Zero harm - Zero disruption

Look up and Live

SOAKWELL REQUIREMENTS	
ROOF AREA DECKED AREA TOTAL AREA	82,65m² 39,74m² 108,30m²
MULTIPLY 0.125 (STANDARD CALCULATION)	1.354m³
VOLUME REQUIRED	1.354m³
SOAKWELLS SHOWN 1 x 1200DIA x 1200 DEEP	1.36m³
TOTAL PROVIDED	1.36m³

EXISTING RESIDENCE:	82.28m ²
EXISTING GARDEN SHED:	18.91m ²
LOT SIZE:	421m²
PROPOSED ADDITION:	36.57m²
PROPOSED CARPORT:	51.98m ²
PROPOSED ALFRESCO:	25.70m ²
TOTAL SITE COVERAGE:	137.73m²
	32.72%

GENERAL NOTES

ALL DIMENSIONS ARE IN MILLIMETRES

- ALL LEVELS, DIMENSIONS POSITIONS AND HEIGHTS TO BE VERIFIED ON SITE BEFORE COMMENCING ANY BUILDING

ALL NECESSARY APPROVALS FROM RELEVANT AUTHORITIES TO BE OBTAINED PRIOR TO THE COMMENCEMENT OF ANY WORK.

ALL DRAWINGS TO BE READ IN CONJUNCTION WITH CONSULTANTS DRAWINGS (IF PROVIDED) AND STRUCTURAL ENGINEERING DRAWINGS.

ALL GUTTER SIZE & VOLUME, DOWNPIPE SIZE & VOLUME, & SOAKWELL VOLUME & QUANTITY REQUIREMENTS TO BE VERIFIED BY ROOF PLUMBER

- ROOF PLUMBER/ BUILDER TO DETERMINE EXISTING SOAKWELL SIZES AND LOCATIONS AND ENSURE ADDITIONAL SOAKWELLS MAKE UP REQUIRED VOLUME PER CALCULATIONS ON SITE PLAN

COUNCIL CITY OF

DRAWN MV DESIGNER **FREMANTLE** MV 34 ETHELWYN STREET HILTON

SITE PLAN

A1.03

ISSUED FOR DA

PRELIMINARY DA ISSUED FOR CLIENT REVIEW

DESCRIPTION

PRINT IN COLOUR

02/09/25


12/08/25

DATE

© copyright of designs shown herein is retained by van der haus, written authority is required for any reproduction

REVISION



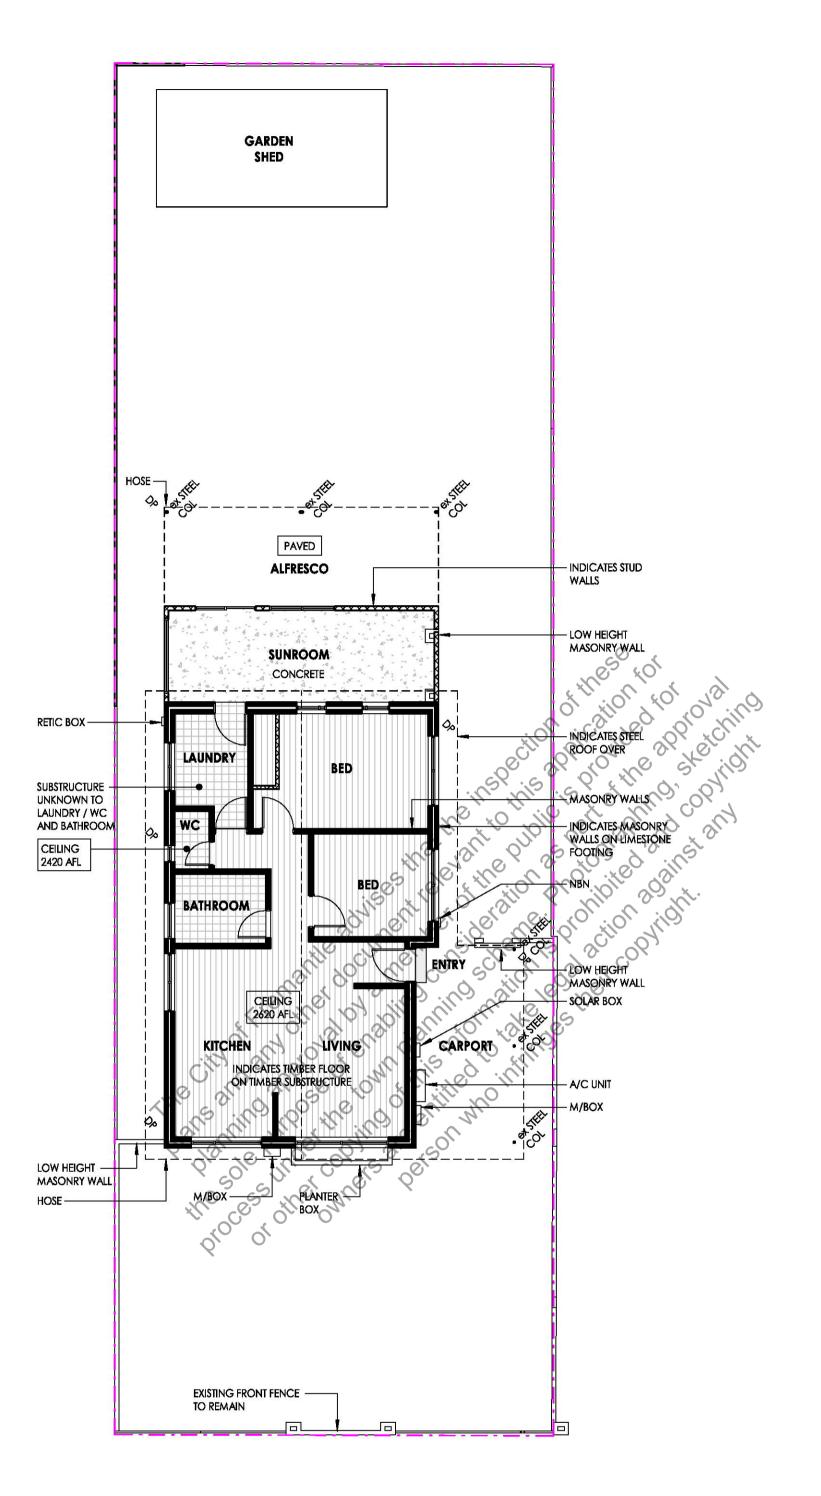



SCALE 1:100



FRONT ELEVATION



FRONT ELEVATION OF HOUSE



REAR OF CARPORT AND SIDE ELEVATION



SIDE ELEVATION



REAR ELEVATION

PLEASE NOTE: IMAGES ARE FOR CONTEXT PURPOSES ONLY AND MAY NOT BE CURRENT

EXISTING HOUSE NOTES

EXISTING HOUSE AND MATERIALS SHOWN INDICATIVE ONLY. BUILDER RESPONSIBLE FOR CONFIRMING STRUCTURE AS REQUIRED

NOTE: DIMENSIONS TAKEN DURING INITIAL PROJECT START UP BY VAN DER HAUS. A VISUAL AND NON INVASIVE INSPECTION WAS TAKEN FROM FLOOR LEVEL TO DETERMINE DIMENSIONS AND LEVELS. BUILDER RESPONSIBLE FOR CONFIRMING SETOUT AND DIMENSIONS PRIOR TO CONSTRUCTION

GENERAL NOTES

- ALL DIMENSIONS ARE IN MILLIMETRES

- ALL LEVELS, DIMENSIONS POSITIONS AND HEIGHTS TO BE VERIFIED ON SITE BEFORE COMMENCING ANY BUILDING

- ALL NECESSARY APPROVALS FROM RELEVANT AUTHORITIES TO BE OBTAINED PRIOR TO THE COMMENCEMENT OF ANY WORK.

- ALL DRAWINGS TO BE READ IN CONJUNCTION WITH CONSULTANTS DRAWINGS (IF PROVIDED) AND STRUCTURAL ENGINEERING DRAWINGS.

- ALL GUTTER SIZE & VOLUME, DOWNPIPE SIZE & VOLUME, & SOAKWELL VOLUME & QUANTITY REQUIREMENTS TO BE VERIFIED BY ROOF PLUMBER

- ROOF PLUMBER/ BUILDER TO DETERMINE EXISTING SOAKWELL SIZES AND LOCATIONS AND ENSURE ADDITIONAL SOAKWELLS MAKE UP REQUIRED VOLUME PER CALCULATIONS ON SITE PLAN

CITY OF FREMANTLE

These Plans Form Part of

DA0343/25


9 Oct 2025

SHEET SIZE	^{јов} 25-181
A2	SCALE AS SHOWN
COUNCIL	DRAWN
CITY OF	MV


DESIGNER

34 ETHELWYN STREET

HILTON

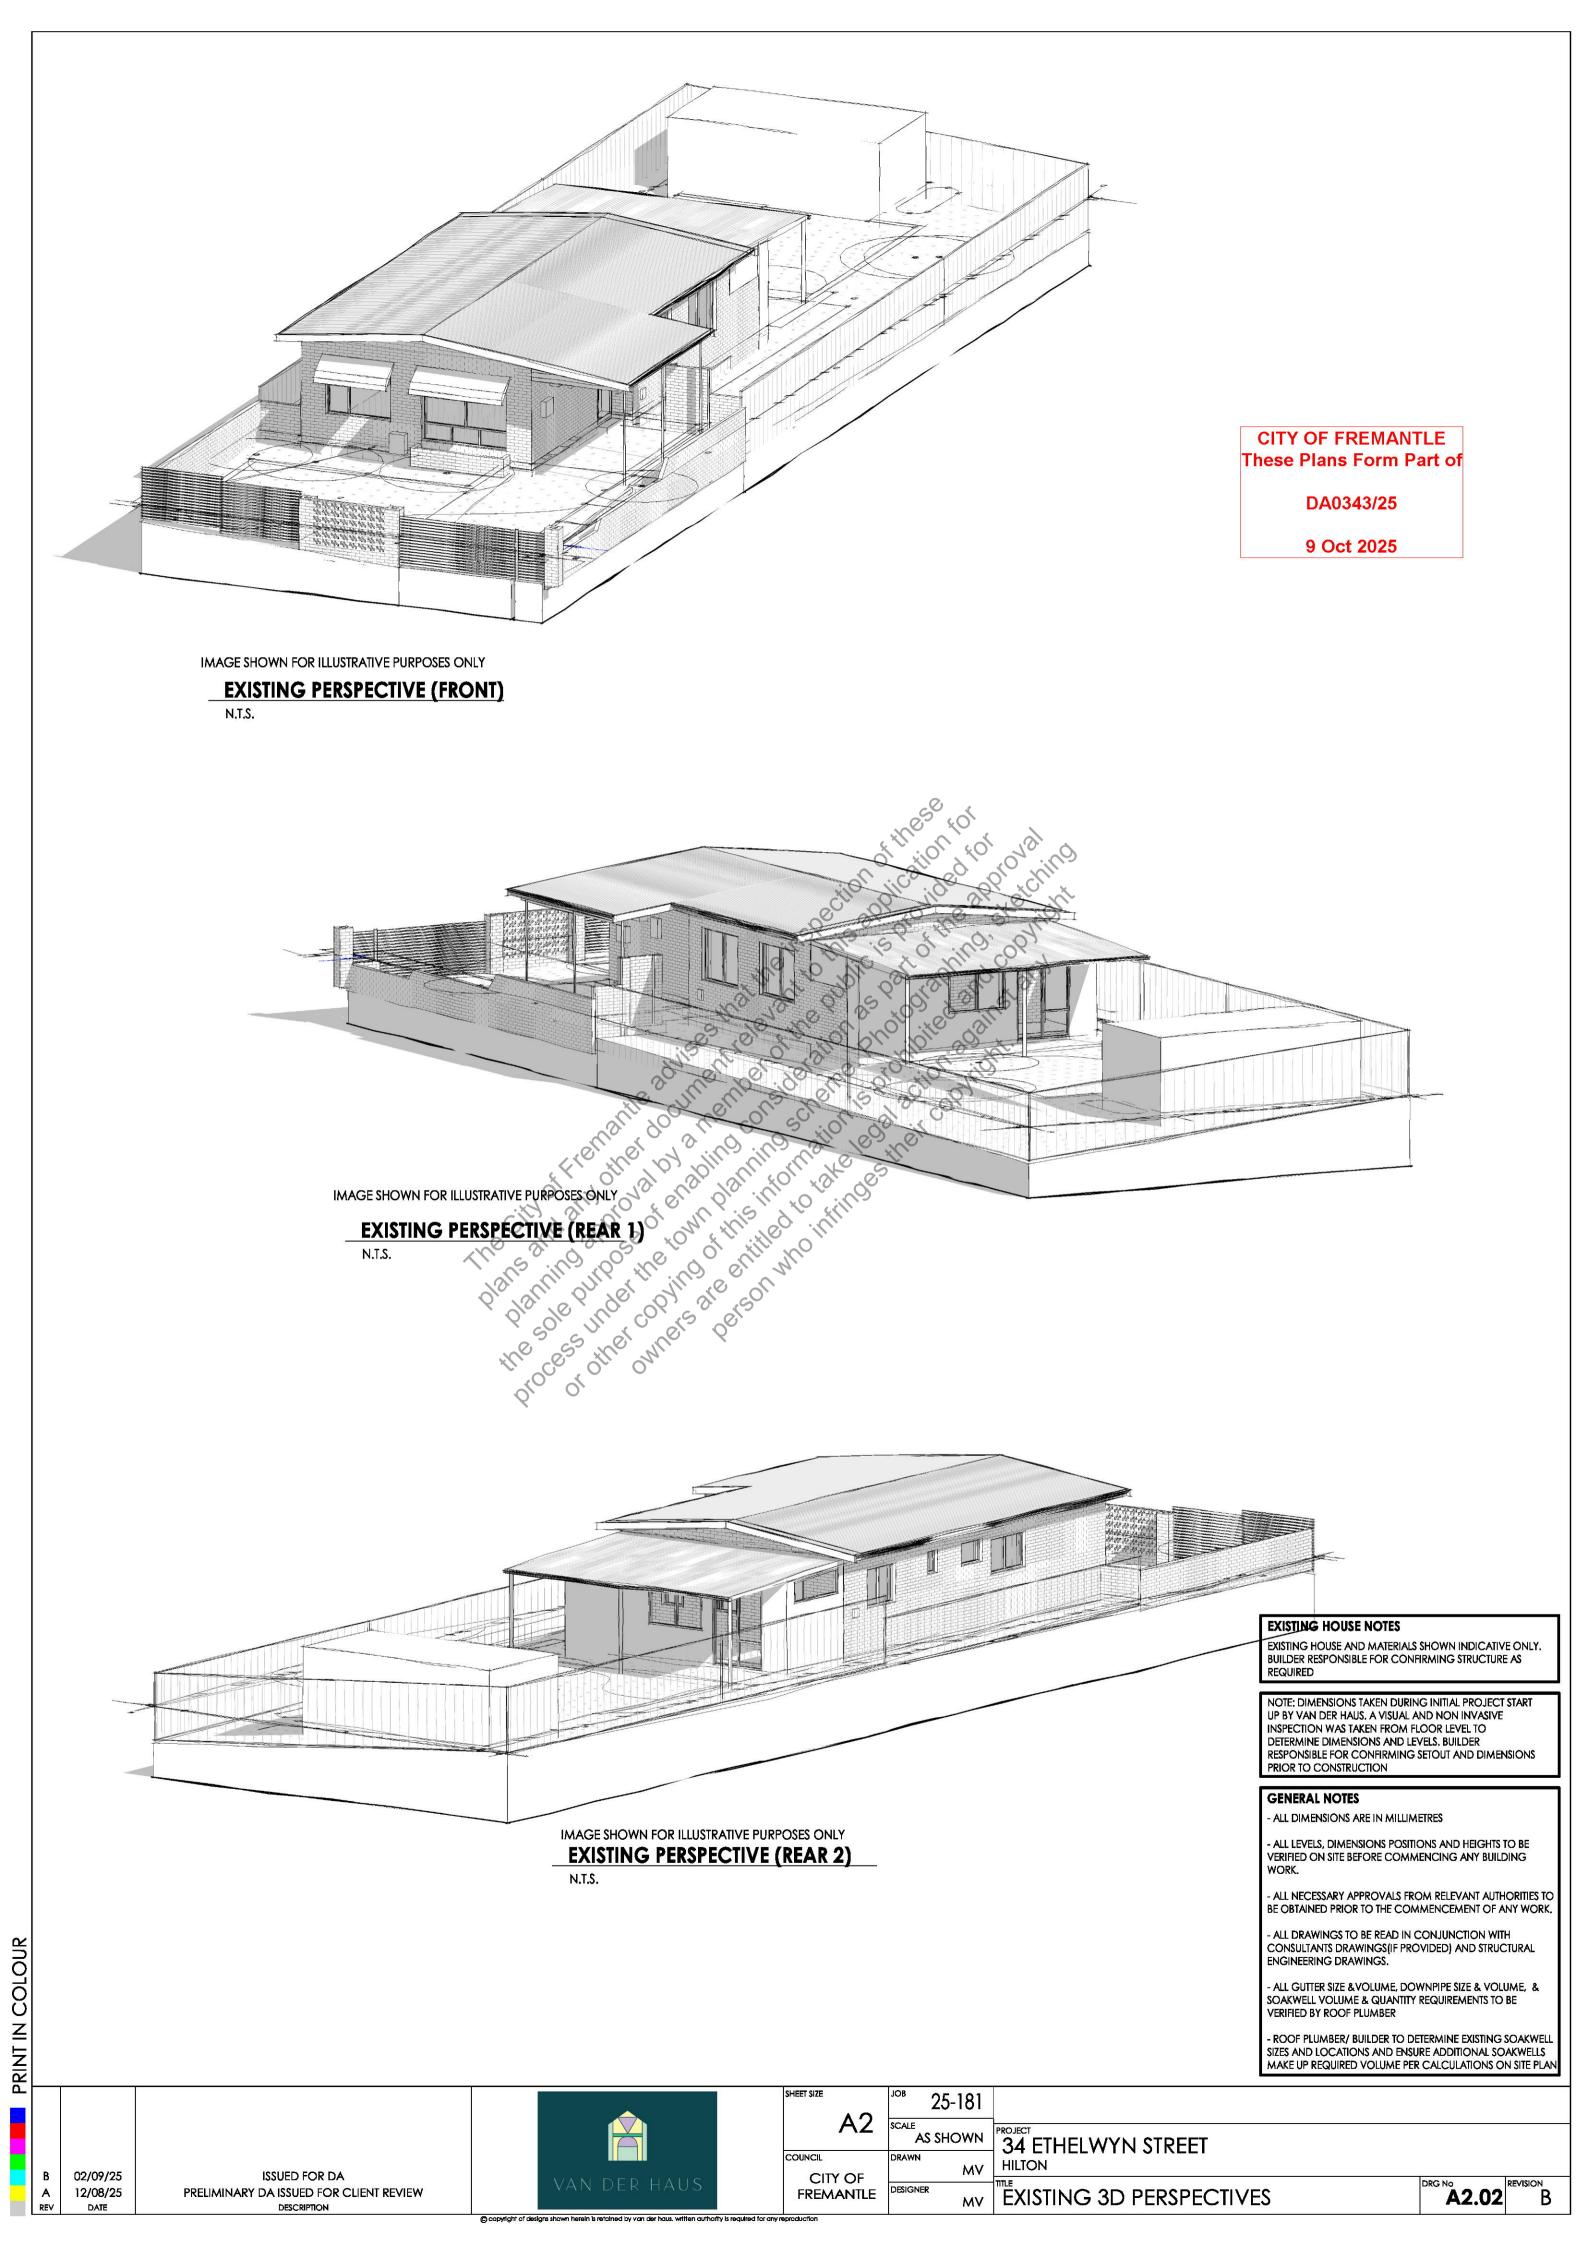



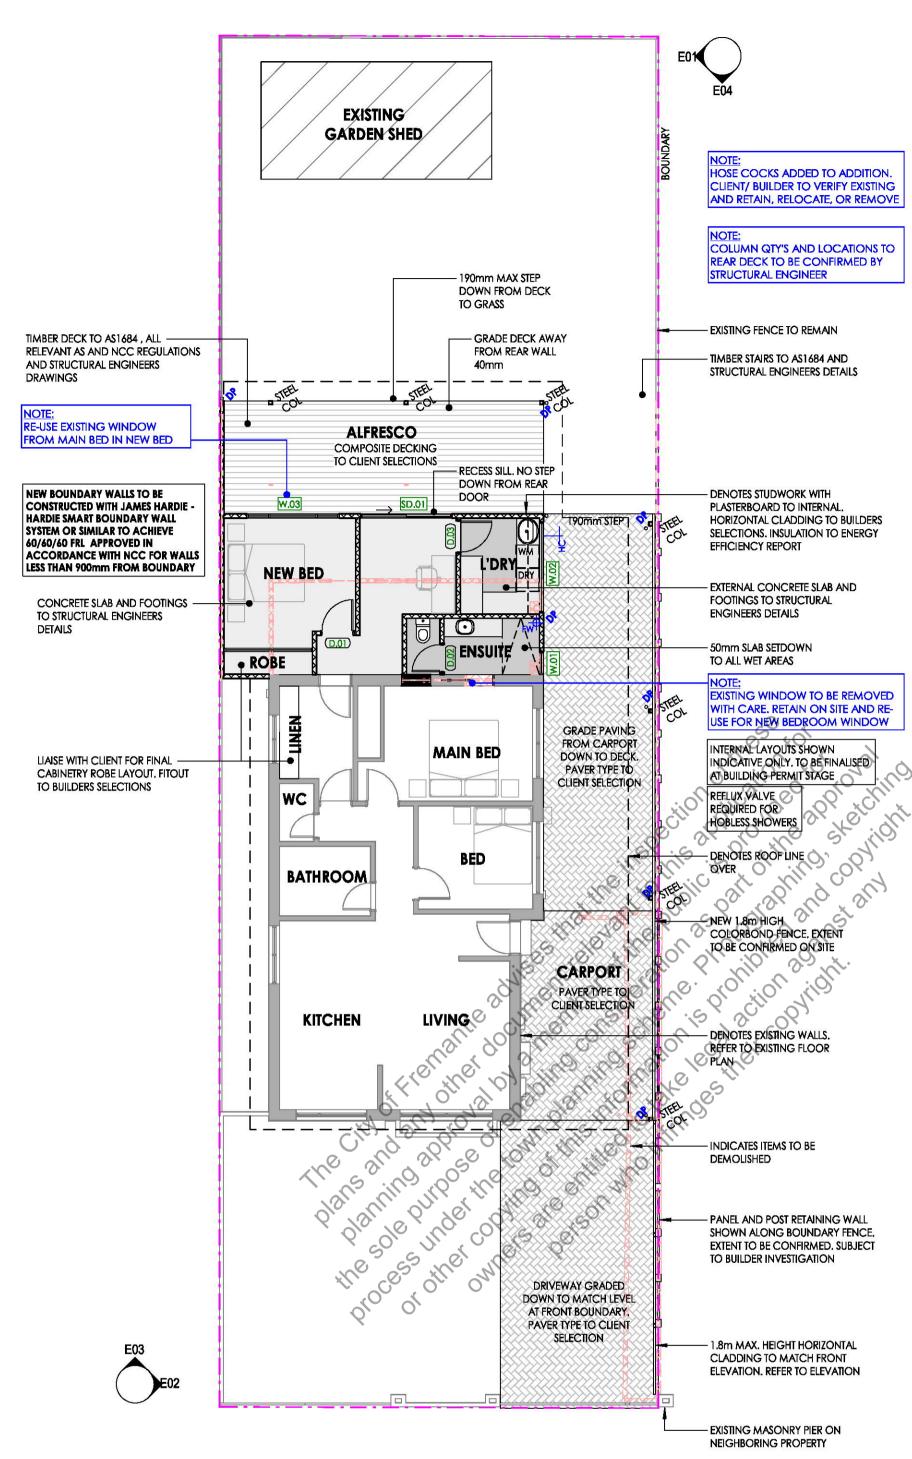

PROPOSED GROUND FLOOR PLAN

SCALE 1:100

CITY OF FREMANTLE
These Plans Form Part of
DA0343/25

9 Oct 2025

DOOR AND WINDOW NOTES

- ALL ARCHITECTURAL DRAWINGS ARE TO BE READ IN CONJUNCTION WITH BUILDER SPECIFICATIONS.

- ALL MATERIALS, FITTINGS AND BUILDING COMPONENTS TO CONFORM TO, & TO BE SUPPLIED AND INSTALLED IN ACCORDANCE WITH THE MANUFACTURER'S SPECIFICATIONS & DETAILS.

- REFER TO ENERGY EFFICIENCY REPORT FOR GLAZING AND INSULATION REQUIREMENTS.

- APPLY WEATHER SEALS TO ALL EXTERNAL DOORS AND

- GLAZING TO COMPLY WITH AS 1288 & AS 2047.

- GLASS THICKNESS AND INSTALLATION REFER TO A.S. 1288-2006.

- REFER TO ENERGY EFFICIENCY REPORT FOR GLASS VALUE AND GLAZING REQUIREMENTS.

- 2x GARAGE DOOR REMOTES TO BE SUPPLIED

- ALL COLOURS AND FINISHES TO CLIENT / BUILDERS SELECTION.

- DOOR AND WINDOW FURNITURE AND HARDWARE TO BUILDERS STANDARD SPECIFICATION AND / OR CLIENT

- WINDOW AND DOOR MANUFACTURERS TO BUILDERS SPECIFICATION AND / OR CLIENT SELECTION.

- DOOR FRAME AND WINDOW PROFILES SHOWN INDICATIVELY. FINAL SELECTION TO BUILDERS SPECIFICATION

AND / OR CLIENT SELECTION.

- ALL GLAZED PANELS, INCLUDING DOORS AND GLAZED LOUVRE PANELS TO BE FITTED WITH SECURITY MESH SCREENS.

JAMES HARDIE GENERAL NOTES

- DETAILS SHOWN INDICATIVE ONLY, BUILDER TO LIAISE WITH CLIENT AND REFER TO JAMES HARDIE (OR APPROVED EQUIVALENT) FOR INSTALLATION AND CONSTRUCTION REQUIREMENTS

LEGEND

DR DRAWER FW FLOOR WASTE

DRY DRYER
WM WASHING MACHINE

FR FRIDGE DW DISHWASHER

DW DISHWASHER BD BIN DRAWER

SG STRIP GRATE

DHO DOOR HEIGHT OPENING

AC. AIR CONDITIONING UNIT - REFER TO BUILDERS SPEC

STEEL COLUMN - REFER TO STRUCTURAL ENGINEERS DWGS FOR DETAIL.

C.O.S. CHECK ON SITE

• DOWNDIRE SIZE

OOWNPIPE - SIZE TBC WITH ROOF PLUMBER & REFER TO BUILDERS SPEC.

FLOOR WASTE - REFER TO BUILDERS SPEC.
INDICATIVE LOCATION SHOWN ON PLAN.
INSTALLED AT PLUMBERS DISCRETION U.O.S

HOSE COCK (EXTERNAL TAP)

HWU HOT WATER UNIT - REFER TO BUILDERS SPEC.

GENERAL NOTES

- ALL DIMENSIONS ARE IN MILLIMETRES

- ALL LEVELS, DIMENSIONS POSITIONS AND HEIGHTS TO BE VERIFIED ON SITE BEFORE COMMENCING ANY BUILDING WORK.

- ALL NECESSARY APPROVALS FROM RELEVANT AUTHORITIES TO BE OBTAINED PRIOR TO THE COMMENCEMENT OF ANY WORK.

- ALL DRAWINGS TO BE READ IN CONJUNCTION WITH CONSULTANTS DRAWINGS(IF PROVIDED) AND STRUCTURAL ENGINEERING DRAWINGS.

- ALL GUTTER SIZE &VOLUME, DOWNPIPE SIZE & VOLUME, & SOAKWELL VOLUME & QUANTITY REQUIREMENTS TO BE VERIFIED BY ROOF PLUMBER

- ROOF PLUMBER/ BUILDER TO DETERMINE EXISTING SOAKWELL SIZES AND LOCATIONS AND ENSURE ADDITIONAL SOAKWELLS MAKE UP REQUIRED VOLUME PER CALCULATIONS ON SITE PLAN

ISSUED FOR DA PRELIMINARY DA ISSUED FOR CLIENT REVIEW DESCRIPTION

PRINT IN COLOUR

02/09/25

12/08/25

DATE




A2 SCALE
AS SHOWN
COUNCIL
COUNCIL
CITY OF
FREMANTLE
DESIGNER
AV PROPOSED GROUNT

PROPOSED GROUND FLOOR PLAN

A4.01

REVISION



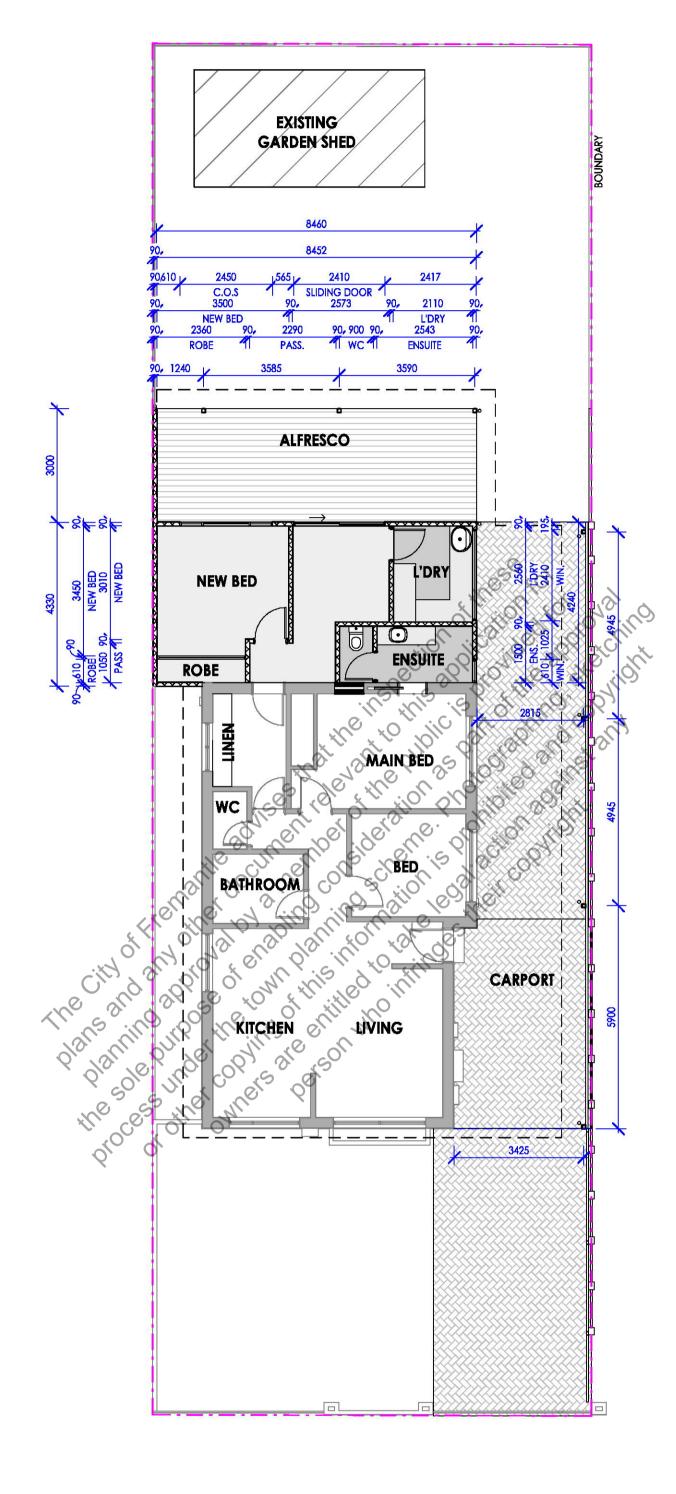

CITY OF FREMANTLE These Plans Form Part of

DA0343/25

9 Oct 2025

PROPOSED SETOUT PLAN

SCALE 1:100

GENERAL NOTES

- ALL DIMENSIONS ARE IN MILLIMETRES

- ALL LEVELS, DIMENSIONS POSITIONS AND HEIGHTS TO BE VERIFIED ON SITE BEFORE COMMENCING ANY BUILDING

- ALL NECESSARY APPROVALS FROM RELEVANT AUTHORITIES TO BE OBTAINED PRIOR TO THE COMMENCEMENT OF ANY WORK.

- ALL DRAWINGS TO BE READ IN CONJUNCTION WITH CONSULTANTS DRAWINGS(IF PROVIDED) AND STRUCTURAL ENGINEERING DRAWINGS.

- ALL GUTTER SIZE &VOLUME, DOWNPIPE SIZE & VOLUME, & SOAKWELL VOLUME & QUANTITY REQUIREMENTS TO BE VERIFIED BY ROOF PLUMBER

- ROOF PLUMBER/ BUILDER TO DETERMINE EXISTING SOAKWELL SIZES AND LOCATIONS AND ENSURE ADDITIONAL SOAKWELLS MAKE UP REQUIRED VOLUME PER CALCULATIONS ON SITE PLAN

02/09/25 ISSUED FOR DA 12/08/25 PRELIMINARY DA ISSUED FOR CLIENT REVIEW DESCRIPTION DATE


PRINT IN COLOUR




SHEET SIZE	ов 25-181	
A2	AS SHOWN	
COUNCIL	DRAWN	
CITY OF	MV	
FREMANTLE	DESIGNER	

34 ETHELWYN STREET HILTON PROPOSED SETOUT PLAN

A4.02

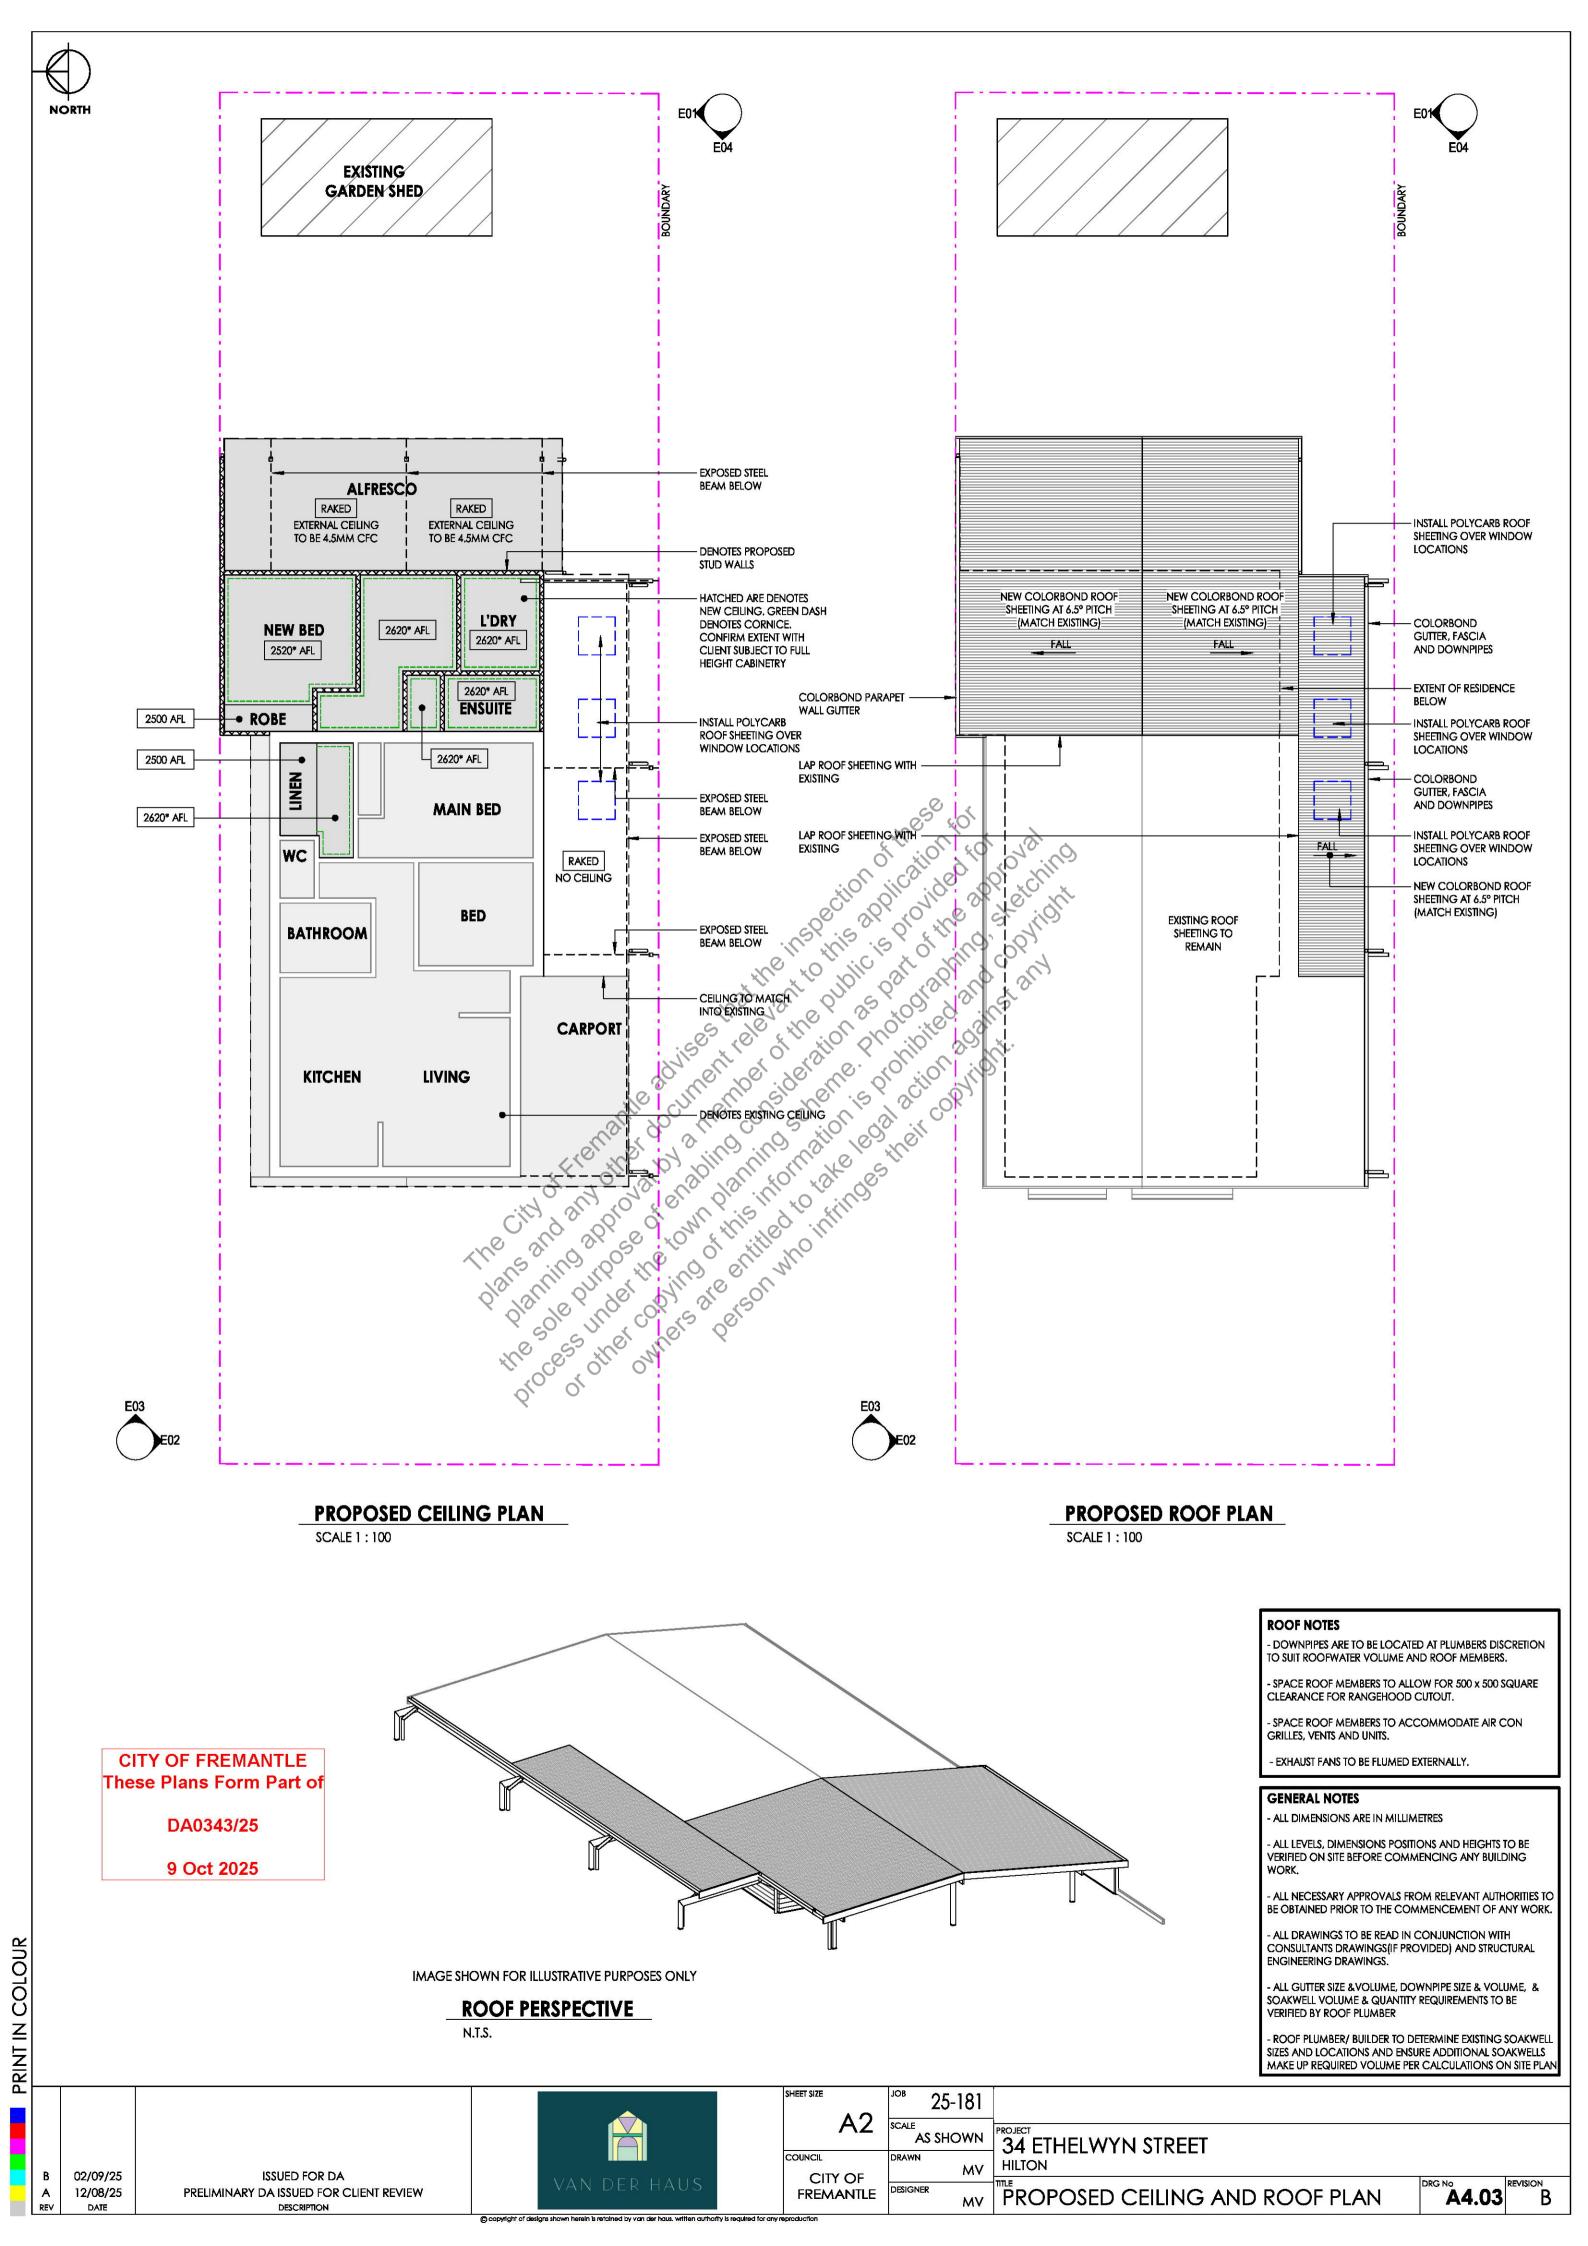

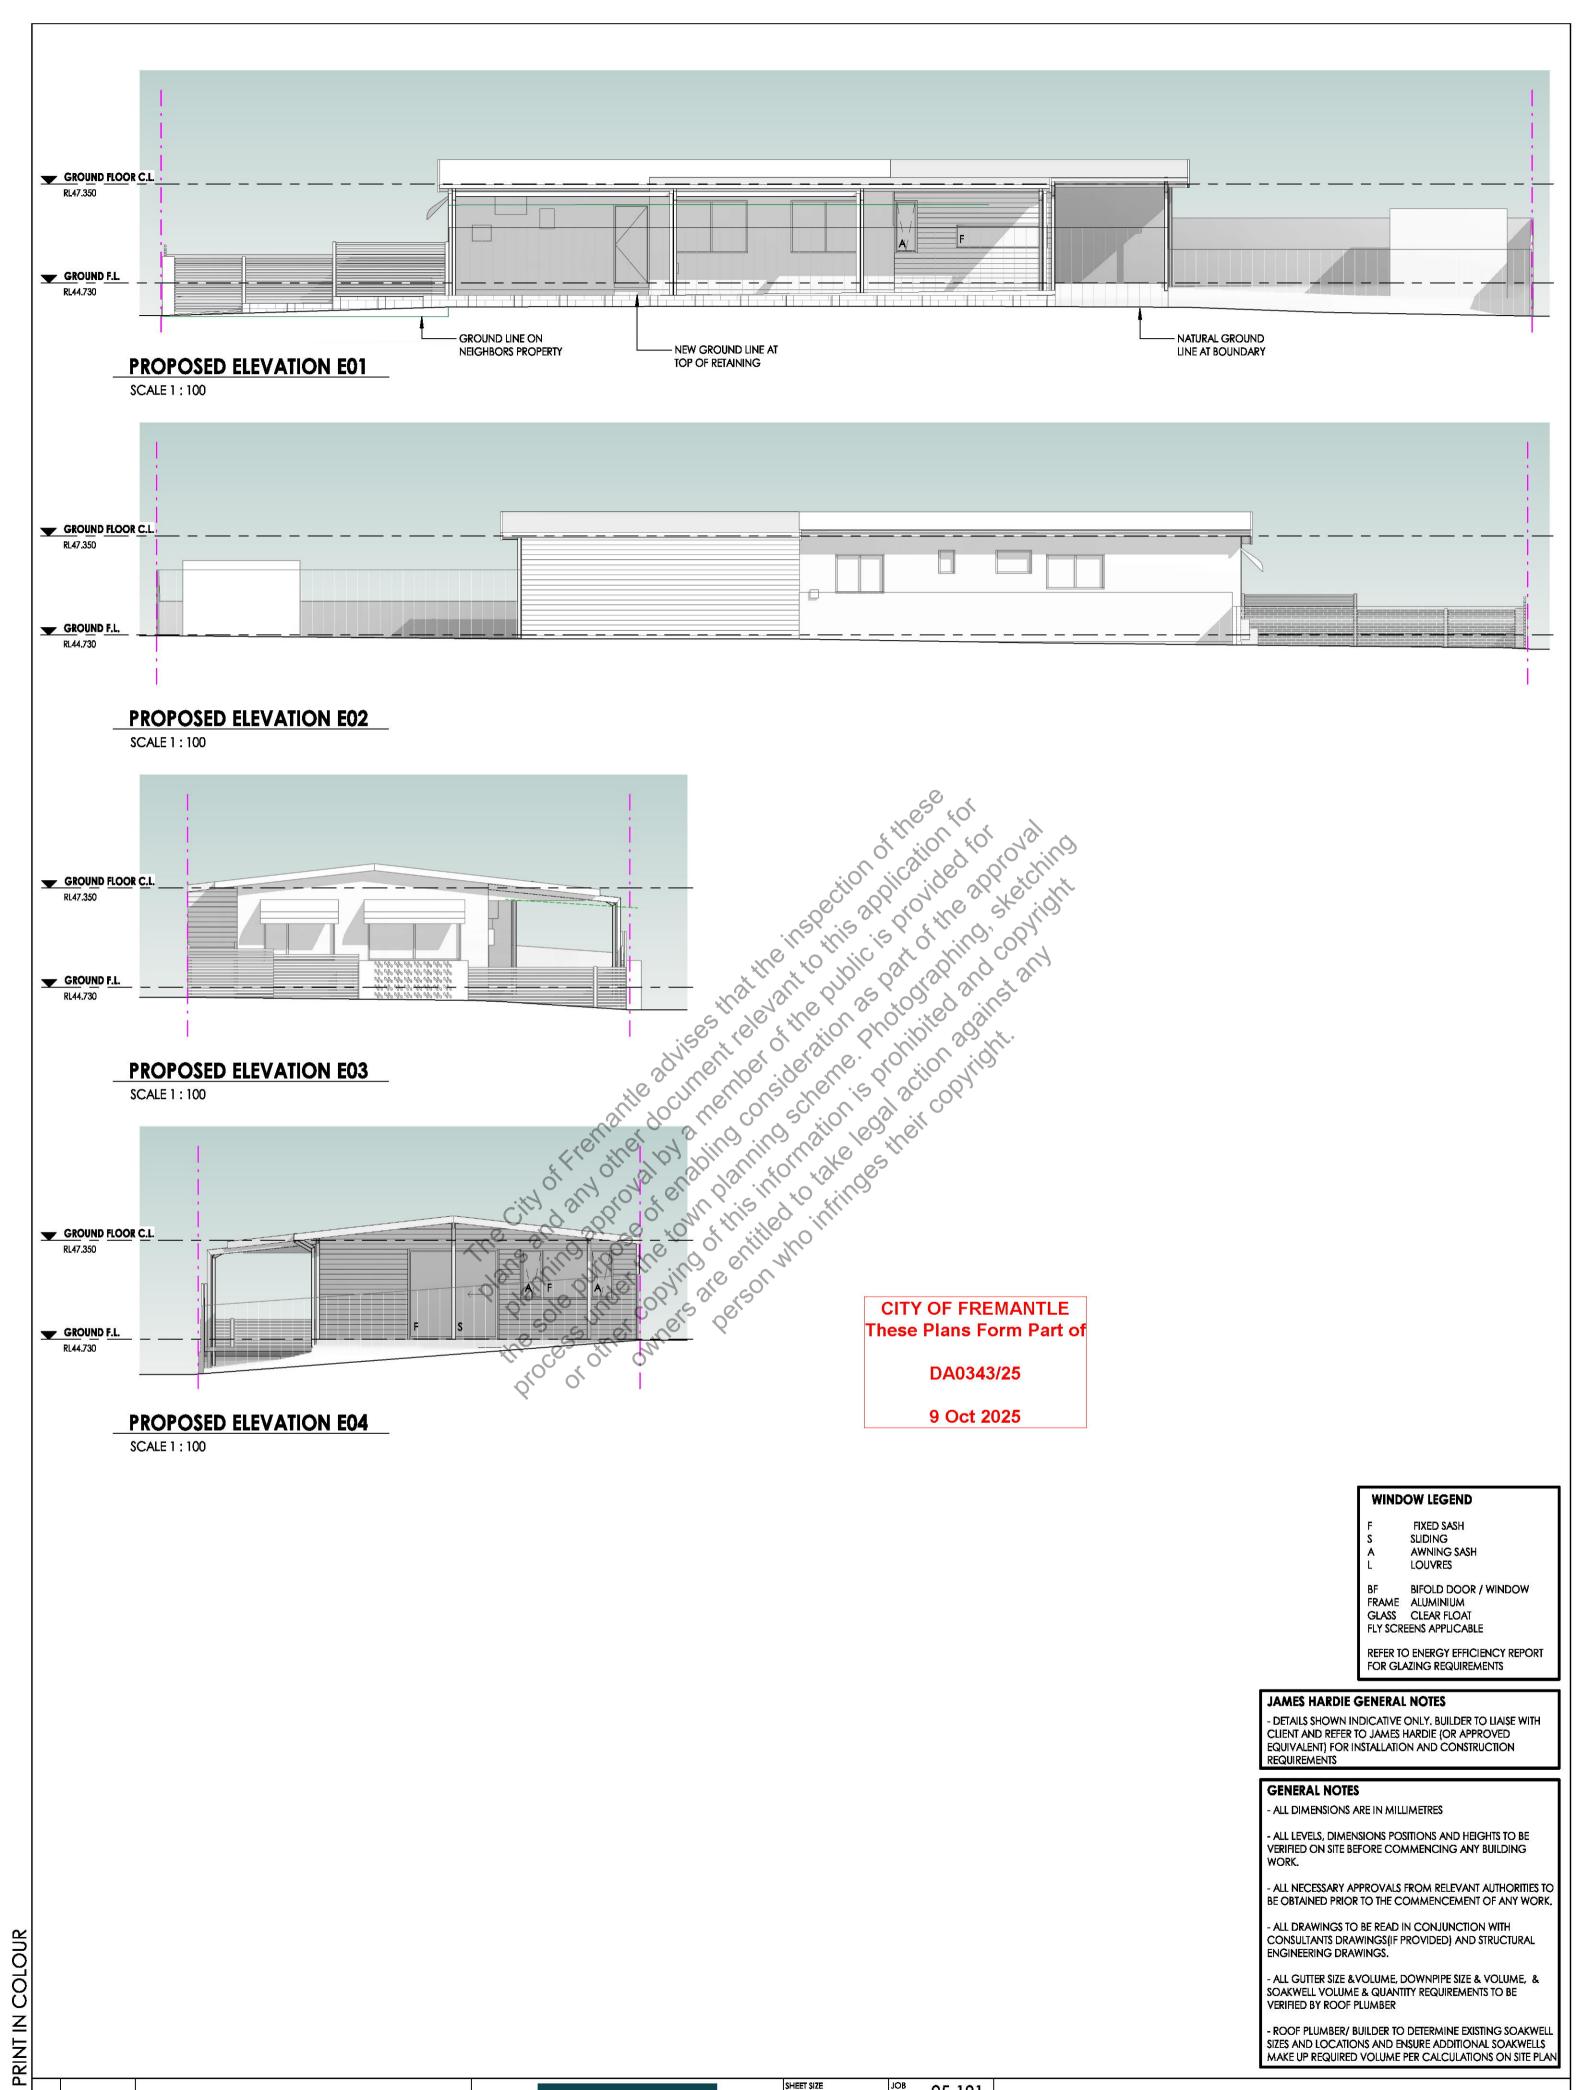

02/09/25 12/08/25 DATE

ISSUED FOR DA PRELIMINARY DA ISSUED FOR CLIENT REVIEW DESCRIPTION



SHEET SIZE COUNCIL CITY OF **FREMANTLE**

25-181 SCALE AS SHOWN DRAWN MV DESIGNER

34 ETHELWYN STREET HILTON

PROPOSED ELEVATIONS

REVISION A4.04