

## **Proposed Site Plan Layout**

**Scale 1:300** 

Final Drawing

**Approval by Client** 

Date\_\_

SITE DETAILS	72
LOT NO.	308
SITE AREA	902m <sup>2</sup>
ZONING	R15
PROPOSED ANCILLARY DWELLING	55.9m <sup>2</sup>
PROPOSED INTERNAL AREA	52.71m <sup>2</sup>
PROPOSED ALFRESCO+CARPORT	N/A
BUSH FIRE RISK ASSESSMENT REPORT	N/A

NOTE:
SITE WORKS BY CLASSIC:
-EXIST SHED & CONCRETE SLAB TO BE REMOVED.

SITE WORKS BY OWNER:
-UPGRADE TO 3 PHASE POWER IF REQUIRED.

-SOAKWELLS.

-DISCONNECT POWER FROM SHED.
-REMOVE SIDE GATE FOR ACCESS.





STREET VIEW

NOTES

**GENERAL NOTES:** 

- 1. ALL DIMENSIONS, ANGLES AND LEVELS MUST BE CHECKED AND VERIFIED ON SITE.
- 2. ALL DIMENSIONS ARE IN METRIC mm (UNLESS OTHERWISE NOTE).
- 3. DO NOT SCALE FROM DRAWINGS. IF IN DOUBT, CONTACT DRAFTING OFFICE.
- 4. ALL MATERIALS AND WORKMANSHIP TO BE IN ACCORDANCE WITH THE B.C.A AND RELEVANT AUSTRALIAN STANDARDS.
- 5. DRAWINGS MUST BE READ WITH ALL OTHER RELEVANT DOCUMENTS, INCLUDING CONDITIONS OF APPROVAL ETC.
- 6. ANY DISCREPANCIES OR CONFLICTING INFORMATION MUST BE RESOLVED WITH THE OFFICE PRIOR TO COMMENCING ANY WORKS.
- 7. SOAKWELL BY OWNER AND LOCATED 1200mm FROM FOOTING AND BOUNDARY.

**GENERAL CONSTRUCTION NOTES:** 

- 1. ALL VEGETATION, RUBBISH, TOPSOIL AND CONTAMINATION FILL SHALL BE REMOVED FROM SITE AND REPLACED WITH CLEAN COMPACTED FILL.
  2. NEW FILL SHALL BE CLEAN, WELL GRADED, YELLOW SAND COMPACTED IN LAYERS NO GREATER THAN 300mm IN DEPTH.
- 3. ALL SAND FILL SHALL BE COMPACTED TO A MINIMUM OF 7 BLOWS PER 300mm FOR 750mm DEPTH. TESTED USING A STANDARD 9kg PERTH SAND PENETROMETER.
- 4. PROVIDE TERMITE TREATMENT UNDER SLAB IN ACCORDANCE WITH AS 3660.1. TERMITE PROTECTION IS REQUIRED WHERE AD JOINING ARE EXPOSED. TIMBER IS TO BE CREATED TO AS 3660.1.

ORIENTATION:



7 Paton Place, Samson, WA 6163

1	APPROVED	ov	<b>61</b>	ICI
1	APPROVED	91	UL	

DATE: 25 JUNE 2025

ATE:	1	1	REVI
NE 2025	ш		

DRAFTER:

DRAWING TITLE

PROPOSED SITE PLAN LAYOUT

DESCRIPTION OF THE BUILDING(S) - BCA ANCILLARY ACCOMMODATION - 1a

SCALE:

1/300

DRAWING NO.


A01

DOUBLE GLAZING DOOR AND WINDOW SCHEDULE WHITE FRAMES ONLY			QUANTITY	
'D2'	SLIDING DOOR (R-H SLIDE)	2143H × 2000W	1	
'W2'	AWNING WINDOW	1115H × 1200W	3	
'W3'	AWNING WINDOW	600H × 600W	1	
'W4'	AWNING WINDOW	600H ×2400W	1	

CITY OF FREMANTLE These Plans Form Part of DA0322/25

25 Sept 2025

SYMBOLS	DESCRIPTION	QUANTITY
cos D/B	DISTRIBUTION BOARD	1
0	LED LIGHTS	15
ᄍ	FLOOR DOPO - 200 AFL	
దద	DGPO - 1100 AFL - AS NOMINATED - DOUBLE	4
å	SOPO - 1250 AFL - AS NOMINATED - SINGLE	2
0	SMOKE DETECTOR	- 1
Oto	CONIBO (EXHAUST FANHEATHLIGHT)	1
盎	DGPO - 1290 AFL- AS NOMINATED - DOUBLE	1
Ь	GPO - 1580 AFL - AS NOMINATED - SINGLE	1
å	EXTERNAL WATERPROOF LIGHT	- 1
Æ	DGPO - 750 APL - AS NOMINATED - DOUBLE	1
ᇫ	SGPO - 1900 AFL - AS NOMBIATED - SINGLE	1
æ	SGPO - 750 AFL - AS NOMINATED - SINGLE	2
<u>—</u>	3.5 KW AIR-CONDITIONER	1
	5 KW AIR-CONDITIONER	1
(DATA	DATA POINT	1
—- <b>¢</b> πν	TV POINT	2
Berry	HEAT PUMP	1
	TOTAL	45

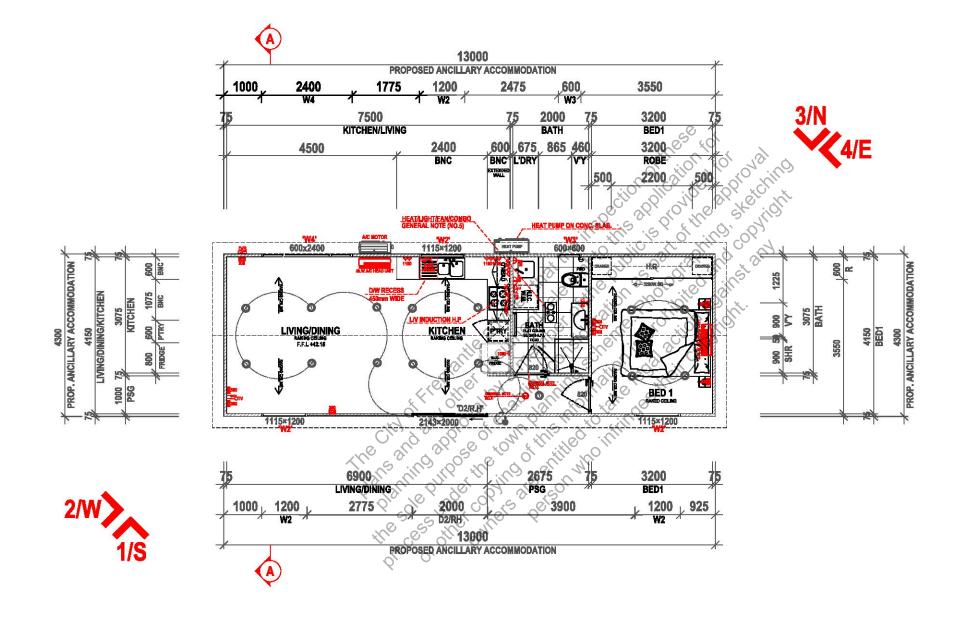

# Proposed Floor & Electrical Plan Scale 1:100

## NOTE:

## **FYTRA PLUS**

- -1x DATA POINT / 2x TV POINT / 2x DBL P.P FOR EACH TV POINT / 2X DOUBLE P.P FOR KITCHEN.
- -HEAT/LIGHT/FAN/ COMBO
- -HEAT PUMP AND LV INDUCTION HOTPLATE INCLUDED.
- -1x 3.5k.W & 1x 5k.W REVERSE CYCLE SPLIT A/C SYSTEM.
- -CLASSIC DOUBLE GLAZED EXTERNAL DOOR & WINDOWS (GLOSS WHITE).
- -CLIENT INSTALLING ROLLER SHUTTERS, SUPERVISOR TO LIAISE WITH OWNER RE-TIMING OF FITTING.

Final Drawing Approval by Client
Date\_\_\_\_\_

### **GENERAL NOTES:**

- 1. DIMENSIONS ARE TO FRAME STUDS ONLY & DO NOT INCLUDE LININGS OR CLADDINGS.
- 2. HEIGHTS ARE FROM TOP OF SLAB. NO ALLOWANCE MADE FOR FLOOR COVERINGS.
- 3. THE BUILDING CODE OF AUSTRALIA FORMS PART OF THESE DRAWINGS, ALL THE BCA REQUIREMENTS ARE TO APPLY INCLUDING THOSE NOT SHOWN OR MENTIONED HERE IN.
- 4. SMOKE ALARMS TO BE HARDWIRED, INTERCONNECTED IN ACCORDANCE WITH NCC V2 PART 9.5 AND AS3786.
- 5. EXHAUST FANS TO BE CONNECTED TO LIGHT SWITCH WITH A 10MIN TIMER, 25 L/S (BATHROOM/SANITARY) AND 40 L/S (KITCHEN/LAUNDRIES) & DIRECTLY TO OUTSIDE AIR. 6. BUILDER IS TO PROVIDE ALL FLASHING AS NECESSARY TO WATERPROOF THE BUILDING.
- 7. WET AREA FLOORS TO BE WATERPROOFED IN ACCORDANCE WITH AS3740 2010 "WATERPROOFING OF WET AREAS WITHIN RESIDENTIAL BUILDINGS. 8. TILING TO WET AREAS BY BUILDER, UNLESS NOTED OTHERWISE.
- 9. ELECTRICAL & PLUMBING FINAL LOCATIONS AT DESCRIPTION OF TRADE TO MEET AS/NZS 3000:2007 & AS/NZS 3500.5.
- 10. SOAKWELL/ STORMWATER IN ACCORDANCE WITH BCA REQUIREMENTS & BUILDING PERMIT CONDITIONS TO BE UNDERTAKEN.
- 11. MINIMUM CEILING HEIGHT IS 2400mm, BATH IS FLAT CEILING, AND LIVING & KITCHEN & BEDROOM 1 ARE RAKED CEILING.
- 12. LIFT OFF HINGES WILL BE USED FOR WC's.

ORIENTATION:

IENTATION:



ADDRESS

7 Paton Place, Samson, WA 6163

APPROVED BY CL

DATE: 25 JUNE 202

REVISIO

DRAWING TITLE:

PROPOSED FLOOR & ELECTRICAL PLAN

DESCRIPTION OF THE BUILDING(S) - BCA ANCILLARY ACCOMMODATION - 1a


SCALE:

1/100

DRAWING NO.:

**A02** 



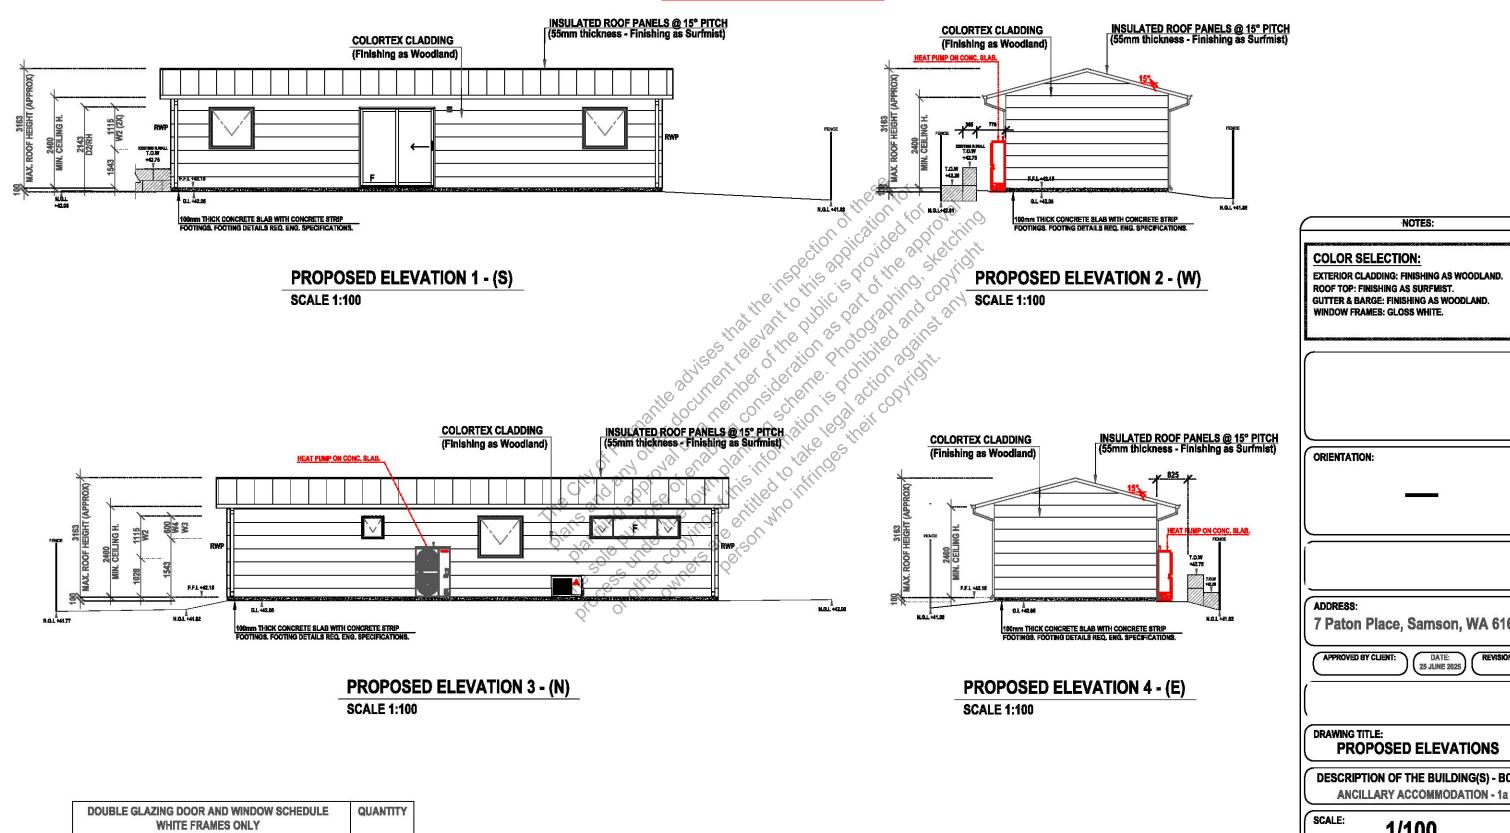

'D2'

'W2'

'W3'

'W4'

**SLIDING DOOR (R-H SLIDE)** 

**AWNING WINDOW** 

**AWNING WINDOW** 

**AWNING WINDOW** 

2143H × 2000W

1115H × 1200W

600H × 600W

600H ×2400W

1

3

1

NOTES: **COLOR SELECTION:** EXTERIOR CLADDING: FINISHING AS WOODLAND. ROOF TOP: FINISHING AS SURFMIST. **GUTTER & BARGE: FINISHING AS WOODLAND.** WINDOW FRAMES: GLOSS WHITE. 7 Paton Place, Samson, WA 6163 DATE: 25 JUNE 2025 DRAWING TITLE: PROPOSED ELEVATIONS **DESCRIPTION OF THE BUILDING(S) - BCA** 

1/100

**A03** 

**Approval by Client** 

Date

**Final Drawing** 

## CONSTRUCTION NOTES:

CLEAR ALL ORGANIC MATTER UNDER THE SITE TO A DEPTH OF 300mm BELOW SLAB LEVEL REMOVAL OF TREES & SHRUBS.

UNDER FOOTINGS AND SLAB TO BE CLEAN FILL AND COMPACTED TO

PROVIDE TERMITE TREATMENT FOR SOIL UNDER SLAB IN ACCORD. WITH AS 3660.1. TERMITE PROTECTION IS REQUIRED WHERE AD JOINING ARE EXPOSED, TIMBER IS TO BE TREATED TO AS 3660.1.

VAPOUR PROOF MEMBRANE (VPM): VPM TO BE 200pm PVC-VPM WITH ALL EDGES LAPPED & SEALED.

CONCRETE: FOR SLAB MIN. GRADE N20/20/80 AT 28 DAYS. REINFORCEMENT TO BE F62 MESH PLACED AT TOP OF SLAB WITH COVER 25mm.

BASE CHANNEL:
TO BE ITEM (B) WITH LEG REMOVED LAID ON DPC & BOLTED TO

INTERNAL LINING:
10mm PLASTERBOARD (GYPROCK) LINING WITH TAPE AND FLUSH JOINTS FASTENED TO METAL STUDWORK (75mm) AT 600mm CTRS. WHITE FINISH (PAINTED) AS SELECTED.

CONNECTORS:
PANEL CONNECTORS WITH FLANGERS TO BE FITTED OVER AND
SCREWED TO THE TOP LID OF THE BASE CHANNEL WITH ONE No.10

BEAM: GLULAM BEAM TO BE ITEM (A) WITH EACH END FIXED WITH CLEATS AS DETAILED, BOLTS TO BE 8mm DIA. MILD STEEL GALVANIZED SCREWS WITH No.10 TEKS.

PURLINS: TO BE FIXED EACH END WITH CLEATS AS DETAILED AND FASTENED

TO BE COLORTEX CLADDING OVER INSULATION ONTO METAL CLADDING AS SELECTED FASTENED TO THE VERTICAL STUDS.

## FINISH AS WOODLAND.

## WINDOWS AND DOORS:

TO BE SLIDING AND HINGED AS SPECIFIED. MODULES IN ALUMINIUM FRAMES. EXTERNAL GLASS SERVICES SUITABLE FOR CATEGORY 3 TERRAIN. POP RIVET FIXED THROUGH THE FLASHING LIP TO ITEM (B) SURROUND AND SEALED WITH A SILICON BEAD. SURROUND AND SEALED WITH A SILICON BEAD.
-WINDOWS & DOORS AS PER PLANS

CEILINGS: 10mm PLASTERBOARD (TAPE & FLUSH JOINTS). WHITE FINISH (PAINTED) AS

INSULBREAK 65 INSERTED BEHIND EXTERNAL WALL CLADDING AND UNDER ROOF SHEET. R2.0 INSULATION BATTS IN ALL WALLS AND R2.5 INSULATION CEILING BATTS ABOVE PLASTERBOARD FLAT CEILING AND RAKED CEILING.

TO BE 'CLASSIC INSULATED PANEL' (55mm) FITTED WITH 175 SCREWS No.14 TEKS, COLORBOND FINISH AS SURFMIST.

**GUTTERS & FLASHINGS:** TO BE ITEM (C) WITH COLORBOND FINISHING AS SELECTED.

## DOWNPIPES AND SOAKWELLS:

CONNECTED TO SOAKWELL BY OWNER AND LOCATED AWAY FROM

TO BE PROVIDED TO CLIENTS REQUIREMENTS AND INSTALLED IN ACCORDANCE WITH WESTERN POWER REGULATIONS. FITTINGS TO

## **MODIFICATIONS TO STRUCTURE:**


MODIFICATIONS TO THE PROPOSED APPROVED STRUCTURE REQUIRES THE APPROVAL OF A CONSULTING ENGINEER.

WALL CLADDING IF IT IS DESIGNED AND CONSTRUCTED IN ACCORDANCE WITH

AN EXTERNAL WALL (INCLUDING OPENINGS AROUND WINDOWS AND DOORS) MUST PREVENT THE PENETRATION OF WATER THAT COULD CAUSE:

STRIP FOOTING DETAILS

**SCALE 1:20** 

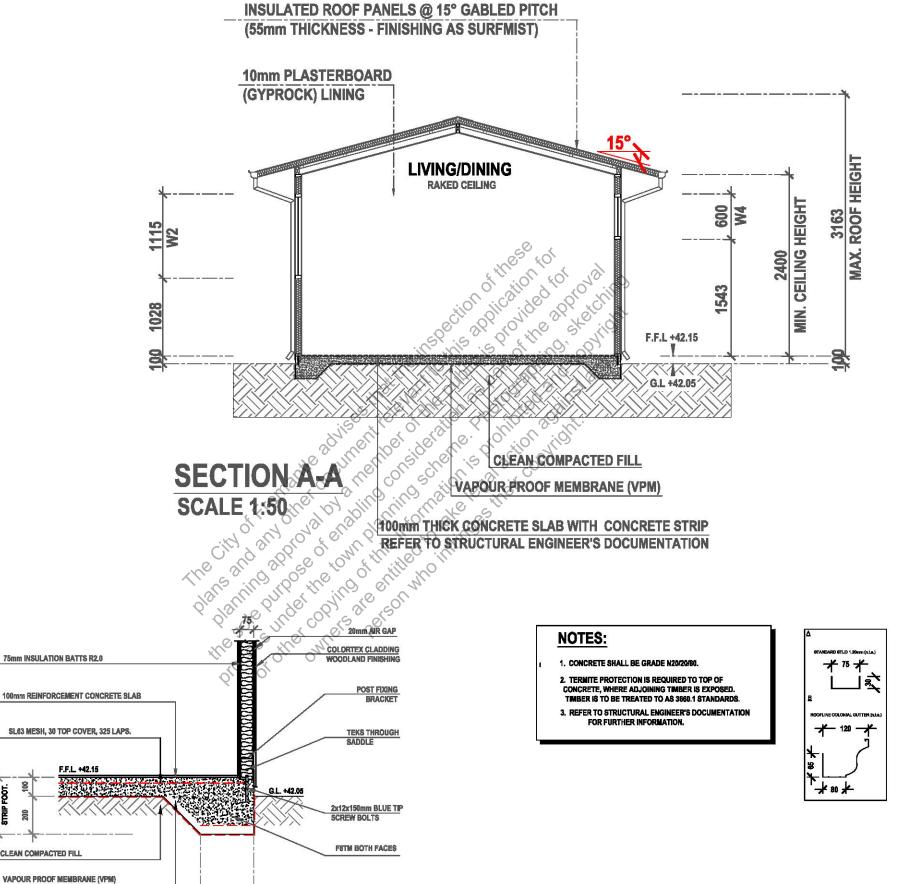

CITY OF FREMANTLE These Plans Form Part of

DA0322/25

25 Sept 2025

NOTES:

STANDARD PANELS SPAN LIMITATION:

7160

3805

4195

**Approval by Client** 

Date

**Final Drawing** 

DRAWING TITLE:

**PROPOSED SECTION AA - STRIP FOOTING** 

DESCRIPTION OF THE BUILDING(S) - BCA **ANCILLARY ACCOMMODATION - 1a** 

7 Paton Place, Samson, WA 6163

25 JUNE 2025

1/50 = 1/20

**A04**